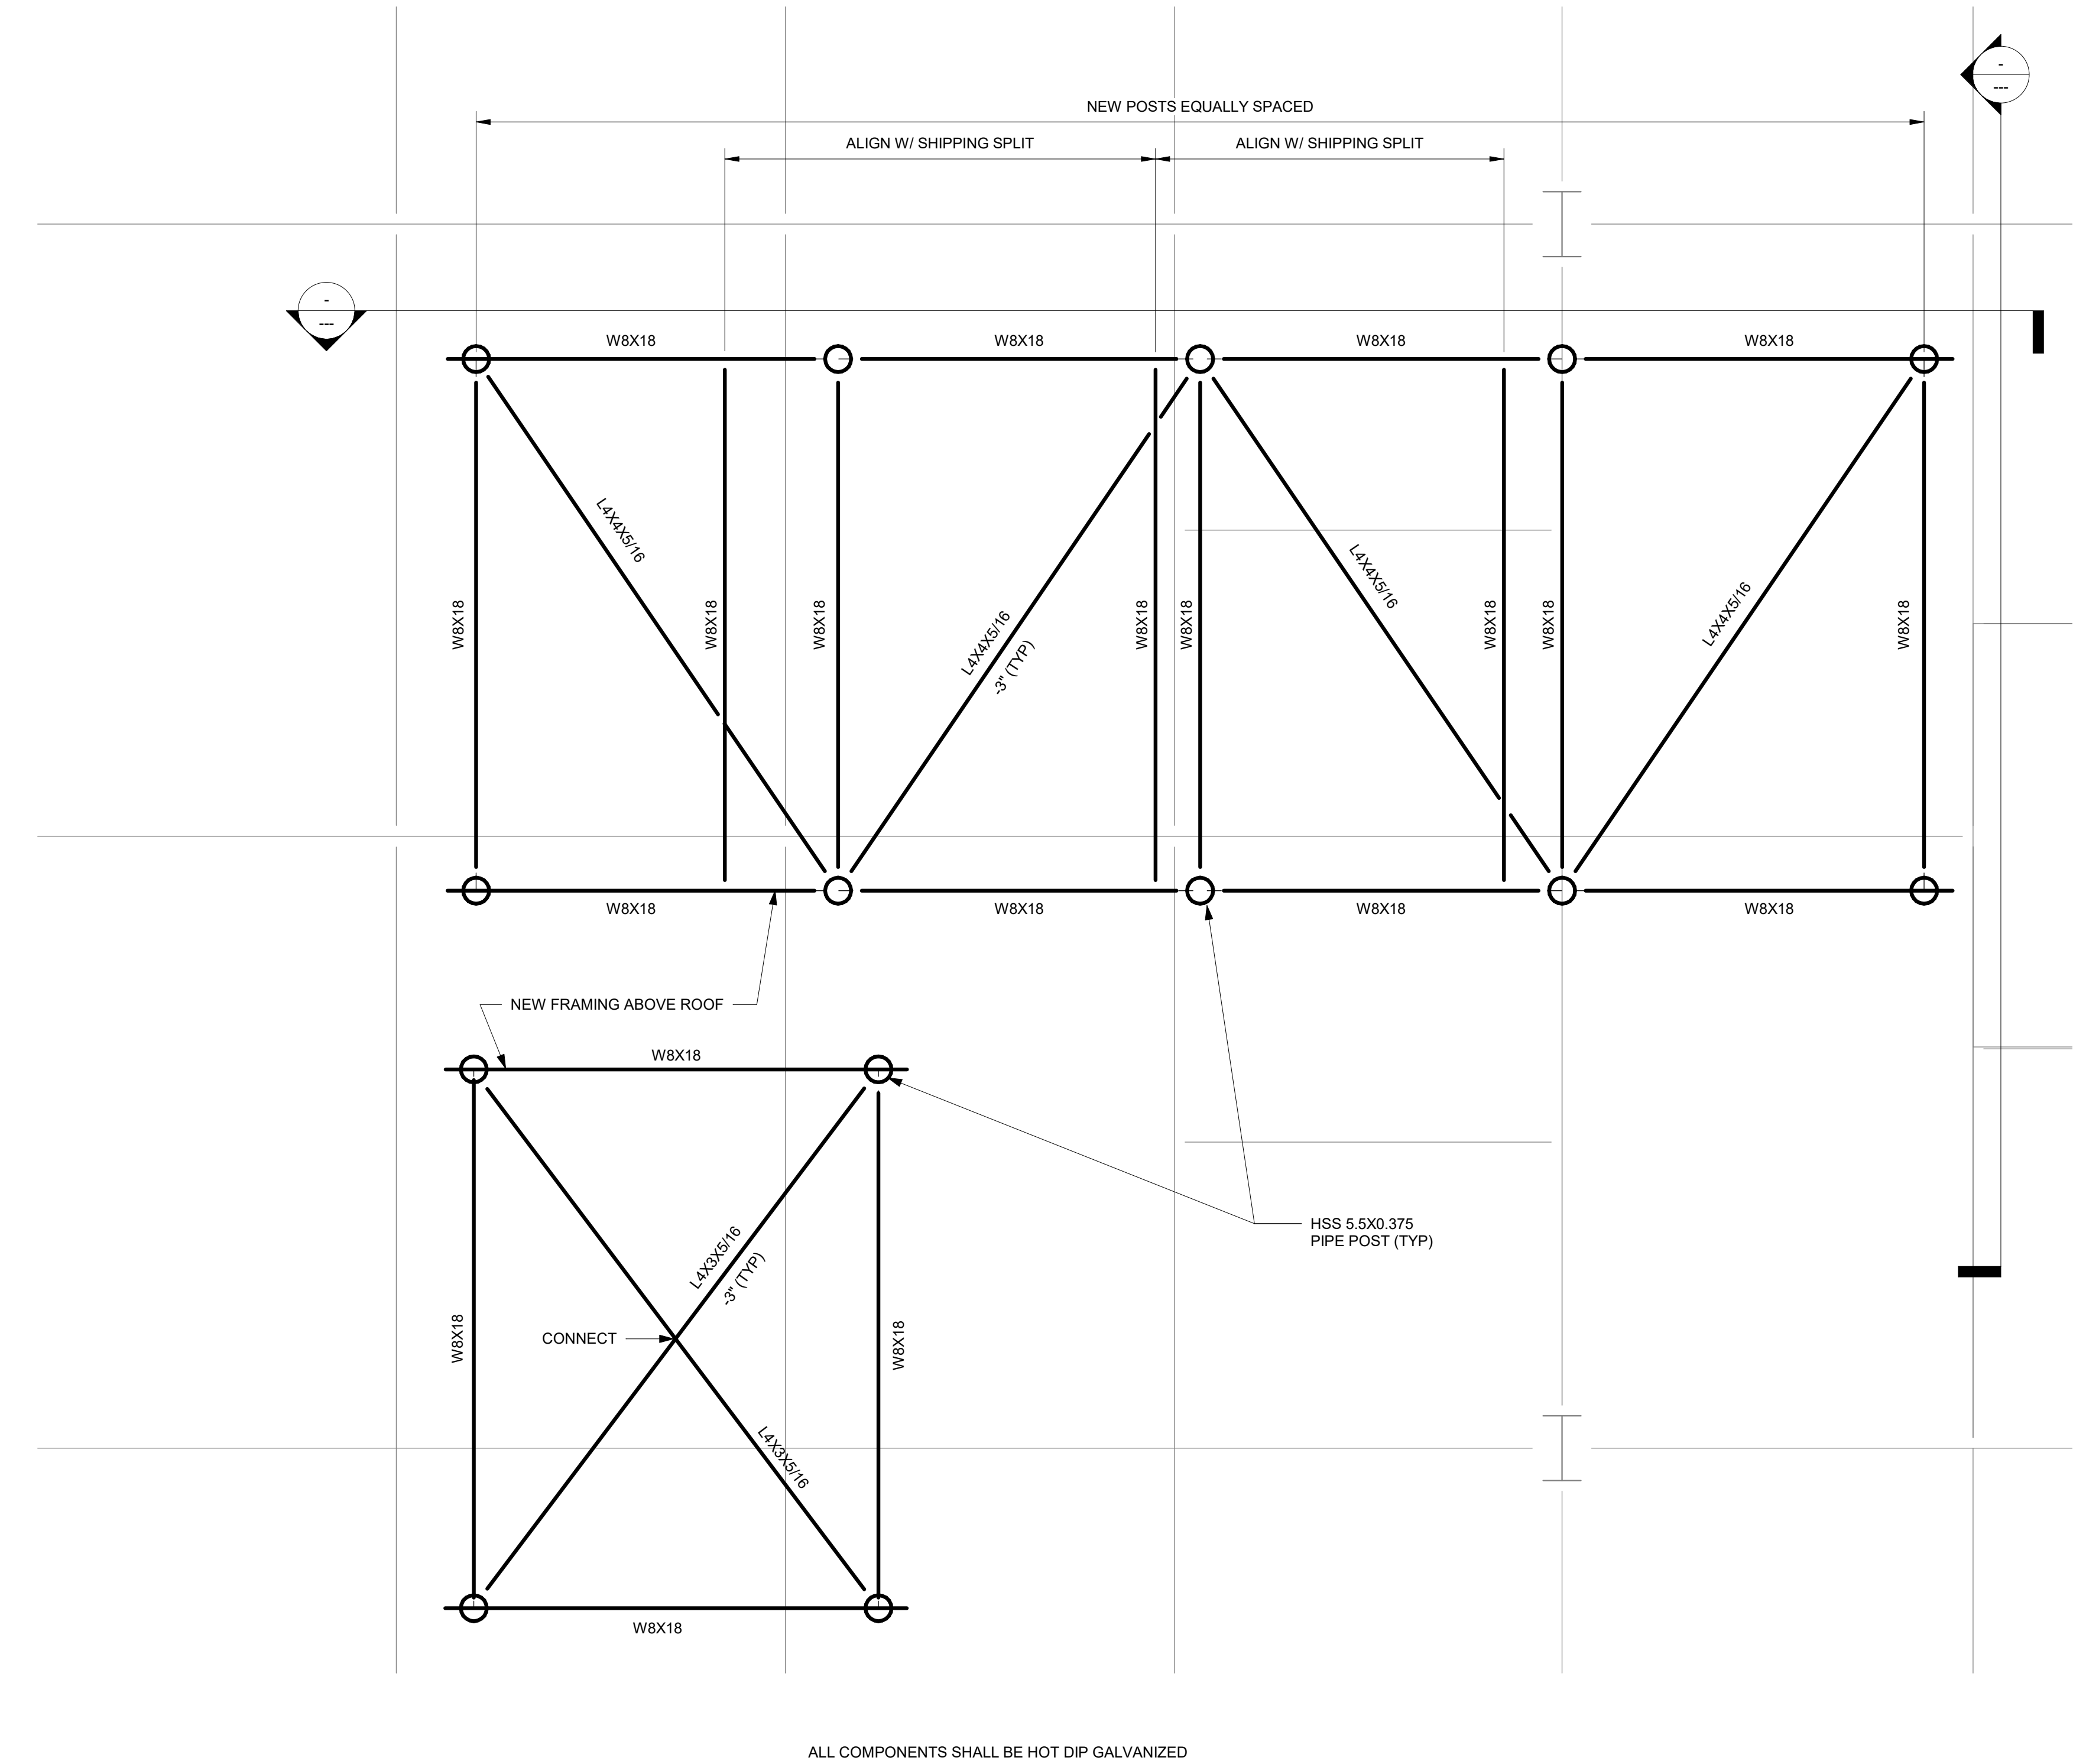


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1 PARTIAL ROOF FRAMING PLAN - NEW WORK
SCALE: 1/2" = 1'-0"

- NOTES:
- SEE SHEET S001 FOR GENERAL NOTES.
 - SEE SHEET S301 FOR TYPICAL DETAILS.
 - RECORD DRAWINGS OF THE WORK AREA ARE NOT AVAILABLE AND THE AREA IS NOT ACCESSIBLE. INFORMATION SHOWN IS ASSUMED, REPRESENTATIVE IN NATURE ONLY, AND FOR INFORMATION ONLY.
 - THE CONTRACTOR SHALL BE RESPONSIBLE FOR MEASURING ALL EXISTING MEMBERS INDICATED ON THE DRAWINGS, BEAMS AND COLUMNS, AND PROVIDE EXISTING MEMBER DIMENSIONS AND SPACING AT THE START OF CONSTRUCTION.
 - CONTRACTOR SHALL VERIFY ALL SIZES AND DIMENSIONS PRIOR TO START OF CONSTRUCTION AND FABRICATION.
 - WORK THIS DRAWING WITH MECHANICAL DRAWINGS FOR LOCATIONS OF MECHANICAL EQUIPMENT. SEE SHEET S301 FOR TYPICAL ROOF OPENING REQUIREMENTS.
 - PROVIDE FLASHING AT ALL EQUIPMENT CURBS AND SUPPORT POST BASES. FLASHING SHALL BE COMPATIBLE WITH EXISTING ROOF INSTALLATION. FOLLOW MANUFACTURER'S STANDARD DETAILS AND RECOMMENDATIONS.
 - CONTRACTOR SHALL FIELD VERIFY TOP OF FINISHED ROOF ELEVATIONS AND COORDINATE WITH FABRICATOR FOR STAIR LAYOUT PRIOR TO START OF FABRICATION.
 - COORDINATE LOCATION OF SUPPORT FRAMING WITH FINAL EQUIPMENT SELECTED.
 - PROVIDE CONNECTION BOLTS FOR MOUNTING EQUIPMENT/ISOLATORS TO STEEL. COORDINATE LOCATION, QUANTITY, AND SIZE WITH MANUFACTURER. SHOP DRILL TO GREATEST EXTENT POSSIBLE. PROVIDE BOLTS THAT ARE COMPATIBLE WITH EQUIPMENT. PROVIDE HOT DIP GALVANIZED CONNECTORS OR AS REQUIRED BY THE MANUFACTURER.

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BID DOCUMENTS

ISSUES

REVISIONS

Sheet Title:
STRUCTURAL PARTIAL ROOF
PLAN

Project Number: 2022-0204.01

Drawn By: CAD

Checked By: AMH

Date: 12/23/22

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Drawing Number

S102